City of Sugar Hill Planning Staff Report DRB-CBD 21-003

DATE:

January 31, 2022

TO:

Mayor and Council, Design Review Board

FROM:

Planning Director

SUBJECT:

Central Business District (CBD) Design Review

Mixed-use development with single family attached residential (townhomes) and

commercial, Rangewater Real Estate, LLC

REQUEST

The City of Sugar Hill has received an application from Rangewater Real Estate, LLC c/o Shane Lanham with Mahaffey Pickens Tucker, LLC requesting design review board approval for a mixed-use development with single family attached residential (townhomes) and commercial land uses.

RECOMMENDED ACTION

Approval of the site plan and buildings in material and architectural detail with the following conditions:

- Final designs shall substantially resemble the attached exhibits labeled Exhibit 1 through 6. Final material and color selections shall be subject to on-site mock-up approval, with identified materials.
- A substantial gateway art feature shall be incorporated into the site design. The final
 design and location shall be approved by the City Manager prior to releasing permits
 and installed prior to final certificate of occupancy.
- 3. Sidewalks along Highway 20 shall be constructed in accordance with the paver details currently approved for use in the Central Business District by the city and GA Department of Transportation (refer to Exhibit 6).
- Ornamental streetlights approved by GA Dept. of Transportation for Highway 20 shall be installed along the Hwy 20 frontage (refer to Exhibit 6).

DISCUSSION

- Land use was previously approved and CBD boundary expanded to include the subject property under rezoning case RZ 21-005 on September 13, 2021.
- Proposed development includes 125 townhomes. There are 15 four-story homes fronting Highway 20. The remaining homes are all three-story. Most are front entry arranged around a pedestrian oriented streetscape or common green space amenity.
- 5,000 square feet of retail space has been planned for the corner of Bailey Avenue and Highway 20 with a small off-street parking area behind. Limited information has been provided for the commercial building and will require subsequent design review board approval prior to permitting.

1/31/2022 Page 1 of 3

APPLICANT/OWNER: Rangewater Real Estate, LLC, c/o Shane Lanham with

Mahaffey Pickens Tucker, LLP Kittle Homes

EXISTING ZONING: General Business District/Town Center Overlay

District/Central Business District (BG/TCO/CBD.

REQUEST: Design review approval, mixed use townhome residential

development.

PROPERTY SIZE: ± 10.579 Acres, Tax Parcel #'s: R7-306-089 & R7-306-

LOCATION: 5000 & 5252 Nelson Brogdon Boulevard.

Parcel is currently an old abandoned cabinet shop with

office and warehouse uses.

DESIGN REVIEW CRITERIA

1. Is the proposed project consistent with the adopted design guidelines for the type of development, and/or the proposed use?

The CBD requirements are designed to foster development of the city center using traditional block patterns characterized by common side walls, building fronts abutting the sidewalk and on-street parking; breaking up large blocks; optimizing multi-modal connectivity and incorporating small public gathering spaces.

The proposed design is consistent with the adopted design guidelines. The buildings provide pedestrian-scale architectural elements and street level commercial use(s) at the corner of Bailey Avenue and Highway 20. The site includes pedestrian oriented streetscape elements and integrates space for public gathering as well.

2. Is the proposed project consistent and compatible with the nature and character of the surrounding areas?

The proposed designs are consistent with the adopted vision and emerging character of Downtown Sugar Hill.

3. Are the site design, landscaping, general design, character, arrangement and scale of buildings, texture, materials and colors of the project similar to or compatible with features or structures in the area.

The proposed elevations and conceptual site plans are compatible in scale, material selection, and general design character with the nearby proposed development.

1/31/2022 Page 2 of 3

4. Will the interior arrangement or use have any effect on exterior architectural features and otherwise complies with the standards of this ordinance?

The design team will need to ensure that any interior changes to the configuration do not adversely affect the layout of the facade.


5. Does the project contribute or resemble the following criteria for considering a design inappropriate?


Character foreign to the area / Arresting and spectacular effects / Violent contrasts of material or color, or intense or lurid colors / A multiplicity or incongruity of details resulting in a restless and disturbing appearance / The absence of unity and coherence in composition not in consonance with the density and character of the present structure or surrounding area.

The proposed changes do not contribute to any of the listed inappropriate design criteria.

1/31/2022 Page **3** of **3**

DRB-CBD 21-003 LOCATION MAP BG, TCO and CBD Overlay Design Review Approval

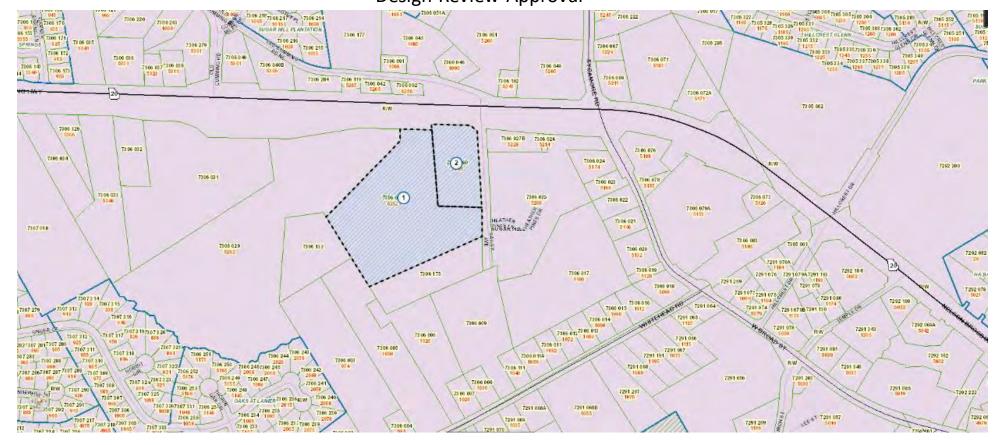

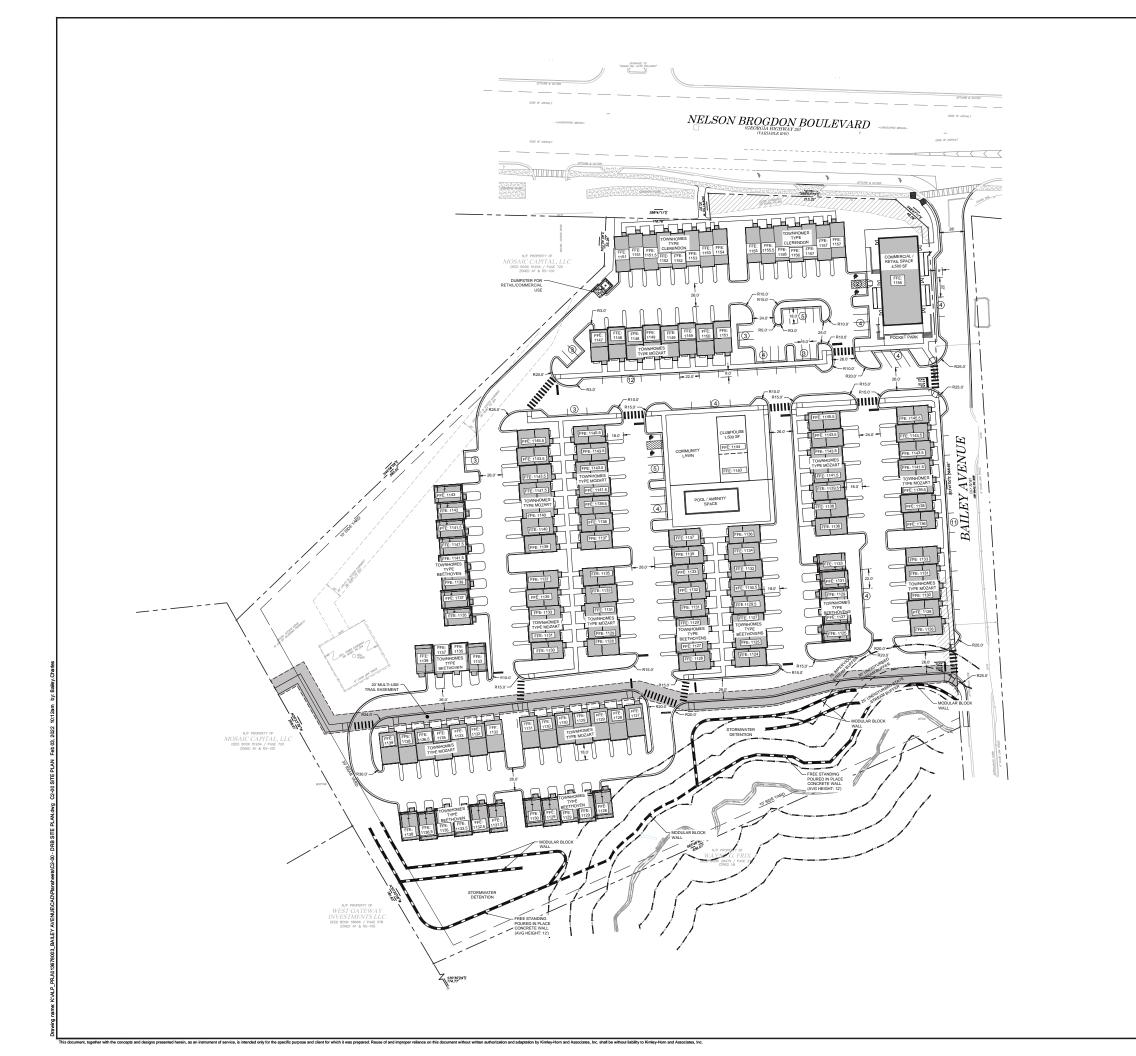

DEVELOPMENT SUMMARY:

SITE SUMMARY:

BG WITH CBD OVERLAY

SITE AREA: 10.579 ACRES TAX PARCELS:

PROPOSED LAND USES & DENSITIES:

ROPOSED USE:

TOWNHOMES AND RETAIL AND/OR COMMERCIAL

Kimley » Horn

RANGEWATER REAL ESTATE 6000 GLENDIGE DRIVE NE SUITE 775 MANNE, AS 1021 2750 MONE, 4731 2750

XIMUM LOT COVERAGE XIMUM IMPERVIOUS: NONE

AXIMUM BUILDING HEIGHT: ALLOWED: PROPOSED

70 FT 4 STORIES

461 SPACES (TOTAL)



SITE PLAN NOTE:

SEWER NOTE:

SUBJECT PROPERTY WILL TIE INTO THE EXISTING PUBLIC SEWE


SURVEY NOTE: URVEY PROVIDED BY GEOSURVEY, LT RANGEWATER SUGAR HILL 8.5252 BALLEY AVENUE, SUGAR HILL, GA'S!

GSWCC CERT. 000002950 (LEVEL II) DRAWN BY BA

DRB SITE PLAN

C2-00



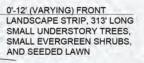

PROPOSED
STREET LIGHT,
TYP.
PROPOSED
MONUMENT SIGN



VICINITY MAP

Trees	Common	Canopy Area / Tree (SF)	Total Canopy Area (SF
25	TRIDENT MAPLE	314	7850
55	"ARMSTRONG" RED MAPLE	962	52910
3	AUTUMN BLAZE RED MAPLE	314	942
14	DOWNY SERVICEBERRY	314	4396
43	PYRAMIDAL EUROPEAN HORNBEAM	314	13502
15	AMERICAN HORNBEAM	314	4710
27	BLUE DEODAR CEDAR	707	19089
11	WHITE FRINGETREE	491	5401
46	GOLDSPIRE MAIDENHAIR TREE	314	14444
4	EMILY BRUNER HOLLY	314	1256
8	WHITE CRAPE MYRTLE	314	2512
24	SOUTHERN MAGNOLIA	1256	30144
18	JANE' MAGNOLIA	491	8838
17	STAR MAGNOLIA	177	3009
3	TUPELO	1590	4770
6	YOSHINO CHERRY	707	4242
23	SCARLET OAK	1590	36570
14	BALD CYPRESS	491	6874
30	DEGROOT'S SPIRE ARBORVITAE	177	5310
11	ATHENA ELM	1590	17490
100	Total Canopy Coverage	53%	244259
100	Total Site Area (AC)	10.579	460821.24

The Samuel Co.	TREE DENSIYT REQUIR	REMENTS			
16 TDU / AC	SITE ACERAGE = 10.579	TOTAL TOU REQU	169.26		
COMMON NAME	CAL. (IN.)	Density Units	QTY.	Units Attained	
TRIDENT MAPLE	2"CAL	0.5	25	12.5	
'ARMSTRONG' RED MAPLE	2"CAL	0.5	55	27.5	
AUTUMN BLAZE RED MAPLE	2"CAL	0.5	3	1.5	
DOWNY SERVICEBERRY	1.5"CAL	0.4	14	5.6	
PYRAMIDAL EUROPEAN HORNBEAM	2"CAL	0.5	43	21.5	
AMERICAN HORNBEAM	2"CAL	0.5	15	7.5	
BLUE DEODAR CEDAR	2"CAL	0.5	27	13.5	
WHITE FRINGETREE	1.5"CAL	0.4	11	4.4	
GOLDSPIRE MAIDENHAIR TREE	2"CAL	0.5	46	23	
EMILY BRUNER HOLLY	1.5"CAL	0.4	7	2.8	
WHITE CRAPE MYRTLE	15 GAL	0	8	0	
SOUTHERN MAGNOLIA	1.5"CAL	0.4	24	9.6	
'JANE' MAGNOLIA	1.5"CAL	0.4	18	7.2	
STAR MAGNOLIA	1.5"CAL	0.4	17	6.8	
TUPELO	1.5"CAL	0.4	3	1.2	
YOSHINO CHERRY	1.5"CAL	0.4	6	2.4	
SCARLET OAK	2"CAL	0.5	23	11.5	
BALD CYPRESS	1.5"CAL	0.4	14	5.6	
DEGROOT'S SPIRE ARBORVITAE	15 GAL	0	30	0	
ATHENA ELM	2"CAL	0.5	11	5.5	
		TOTAL TOU PRO	VIDED=	169.6	
		TREE DENIS	SITY REQU	JIREMENT SATISF	

NOTE: EXISTING TREES TO BE SURVEYED AND COUNTED TOWARDS TREE DENSITY UNITS AS APPLICABLE.

PARKING TREE CALCULATIONS

OFF-STREET PARKING LOT PLANTING REQUIREMENTS
PER CITY OF SUGAR HILL BUFFER, LANDSCAPE, TREE ORDINANCE:


PROVIDE 1 TREE PER 5 PERIMETER PARKING SPACES TOTAL PARKING SPACES = 413

TOTAL PARKING SPACES = 413 TREES REQUIRED (413/5) = 82.6 TREES PROVIDED = 370

GENERAL NOTES

OWNER/DEVELOPER: RANGEWATER REAL ESTATE
 5605 GLENRIDGE DRIVE NE, SUITE 775
 ATLANTA, GA 30342
 CONTACT: TREVOR KIERECKI
 TEL: (470) 312-2881

LANDSCAPE ARCHITECT: IRONWOOD DESIGN GROUP
 425 S ATLANTA STREET, ROSWELL, GA 30075
 SUITE 120

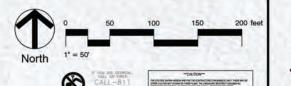



STC2020-00053

SUGAR HILL
5000 & 5252 BAILEY AVENUE
SUGAR HILL, GA 30518
LAND LOT 306, 7th DISTRICT

Stamp

ESTATI

RANGEWATER REAL



Revisions

Sheet Title

LANDSCAPE CONCEPT PLAN

Job No: 2021-084 Scale: 1" = 50'-0" Date: 1-28-2022 Drawn By: STS

LC-1.0



Highway 20 Fronting Facades





Pearl Grey Plank Siding



Aged Pewter Hardie Plank Siding




Arctic White Hardie Plank Siding



Ansley Park Brick



Mosstown Brick

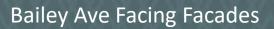







Arctic White Hardie Plank Siding



Ansley Park Brick



Mosstown Brick



Internal Facing Facades









Ansley Park Brick



Mosstown Brick



White Board and Batten



Pearl Grey Plank Siding

DESCRIPTION

The ACN/ARC/CLB Generation Series LED is a marriage of traditional shapes and contemporary styling. Its superior photometrics offer excellent illumination and uniformity for many of today's applications. Its styling blends well in many settings - historic districts, downtown streetscapes, roadways, residential neighborhoods, as well as city parks and educational campuses. The Generation Series LED sets a new standard for decorative post top luminaires.

S	t	r	e	e	t	W	0	r	ks
---	---	---	---	---	---	---	---	---	----

Catalog #	Туре
Project	
Comments	Date
Prepared by	

SPECIFICATION FEATURES

Construction

HOUSING: Heavy-duty cast aluminum housing and removable door. A single quarter turn fastener on the removable door provides tool-less access to wiring compartment, CAGE ASSEMBLIES: Cage assembly uprights and medallions are manufactured of heavy-duty cast aluminum and mounted to the exterior of the base housing via four stainless steel fasteners. Cage rings constructed of extruded aluminum and finished to match housing. TOPS AND FINIALS: Choose from multiple spun aluminum or acrylic tops and cast aluminum finials for customized fixture style. All solid tops are made of heavy-duty spun aluminum. TWISTLOCK GLOBE: The optional twistlock assembly offers ease of maintenance through instant access to both the LED and wiring compartment by twisting the top refractor assembly and lifting it from the mating lock plate.

Optical

REFRACTIVE GLOBE: High efficiency refractive optical systems are precisely designed utilizing a combination of refractive and reflective prisms. Available in Type III or Type V distributions. Lighting grade acrylic ensures long lasting optical clarity and resistance to discoloration.

Electrical

120-277V 50/60Hz operation. 10kV/10kA common and differential mode surge protection standard. Thermal management transfers heat rapidly away from the LED source for optimal efficiency and light output. Ambient operating temperature from -40°C to 40°C. Standard three-position tunnel type compression terminal block.


Mounting

Base casting slipfits over a standard 3" O.D. tenon and secured via four stainless steel allen head fasteners. 3G vibration tested.


Finish

Cast and soun components finished in a five-stage premium TGIC polyester powder coat paint, 2.5 mil nominal thickness for superior protection against fade and wear. Consult your Streetworks representative for a complete selection of standard colors including black, bronze, grey, white, dark platinum, graphite metallic and hartford green. RAL and custom color matches available.

Warranty Five-year warranty.

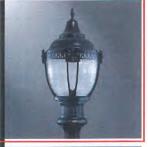



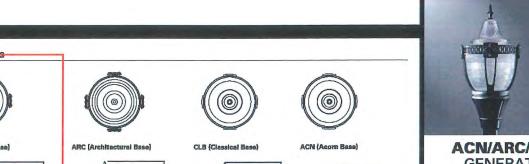



LED

DECORATIVE POST TOP LUMINAIRE







CERTIFICATION DATA

Effective Projected Area 2.1 Square Feet

SHIPPING DATA Approximate Net Weight: 50 lbs. (23 kgs.)

> TD516011EN December 7, 2020 5:11 PM

